



- * NEW LEVEL
- + EXISTING LEVEL

NOTE: CONNECT ALL FLOOR DRAINS
TO OSD TANK AND ALL ROOF
PIPES TO RAINWATER TANK.

NOTES

1. THESE DRAWINGS ARE TO BE READ IN CONJUNCTION WITH THE ARCHITECTURAL DRAWINGS, STRUCTURAL DRAWINGS AND THE SPECIFICATON.

2. PRIOR TO COMMENCEMENT OF WORKS THE CONTRACTOR SHALL SATISFY HIMSELF OF THE CORRECT LOCATION OF EXISTING SERVICES WHETHER INDICATED OR NOT ON THE PLANS. ANY DAMAGE TO EXISTING SERVICES SHALL BE RECTIFIED AT THE CONTRACTORS EXPENSE.

3. TRAFFIC MANAGEMENT MEASURES HAVE TO BE IMPLEMENTED

AND MAINTAINED DURING CONSTRUCTON, ALL IN ACCORDANCE WITH COUNCIL'S REQUIREMENTS. THE CONTRACTOR SHALL MAINTAIN SAFE PEDESTRIAN ACCESS ALONG THE FOOTPATH.

4. THE CONTRACTOR SHALL EFFECT TEMPORARY DRAINAGE MEASURES TO AVOID LOCALISED PONDING OF SURFACE RUN-OFF.

5. REFER TO ARCHITECT'S DRAWINGS FOR ALL DETAILS (LEVELS, GRADING ETC.) OF DRIVEWAYS, CONCRETE AND PAVED AREAS, AND RETAINING WALL TYPES ADN LOCATIONS.

6. REFER TO LANDSCAPE ARCHITECT'S DRAWINGS FOR DETAILS AND EXTENT OF ALL LANDSCAPED AREAS.

AND EXTENT OF ALL LANDSCAPED AREAS.

7. ALL SWD PIPES ARE UPVC AT 1.0% MINIMUM GRADE (UNO).

8. SWD PITS CAN BE PRE-CAST SIZED AS FOLLOWS:

450mm SQ. UP TO 600mm DEEP


600mm SQ. UP TO 1000mm DEEP


9. ALL PITS LOCATED IN TRAFFICABLE AREAS, (IE, DRIVEWAYS)
TO HAVE MEDIUM DUTY GRATED COVERS SUITABLE FOR
WITHSTANDING LOADS ASSOCIATED WITH SMALL TRUCKS.


10. PROVIDE STEP IRONS TO ALL PITS GREATER THAN 1.2m DEEP.

11. THE CONTRACTOR SHALL IMPLEMENT ALL SOIL EROSION AND
SEDIMENT CONTROL MEASURES PRIOR TO COMMENCEMENT OF
WORKS.


12. TOPSOIL SHALL BE STRIPPED DN STOCKPILED OUTSIDE
HAZARD AREAS SUCH AS DRAINAGE LINES. THIS TOPSOIL IS TO
BE RESPREAD LATER ON AREAS TO BE REVEGETATED.
13. THE CONTRACTOR SHALL REGULARLY MAINTAIN ALL SEDIMENT
AND EROSION CONTROL DEVICES AND REMOVE ACCUMULATED SILT
FROM SUCH DEVICES. ALL SILT REMOVED SHALL BE DISPOSED OF
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MAINTAINING THESE DEVICES SHALL BE AT LEAST UNTIL ALL
DISTURBED AREAS ARE REVEGETATED AND FURTHER AS MAY BE
DIRECTED BY THE SUPERINTENDENT OR COUNCIL.
14. THE CONTRACTOR SHALL MAINTAIN DUST CONTROL UNTIL
FINAL COMPLETION OF WORKS.

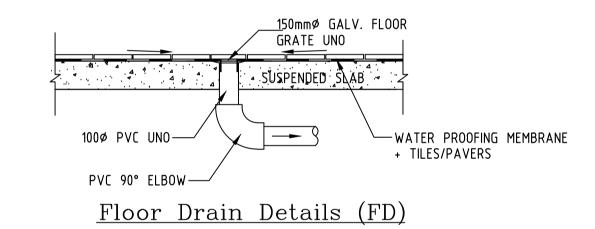


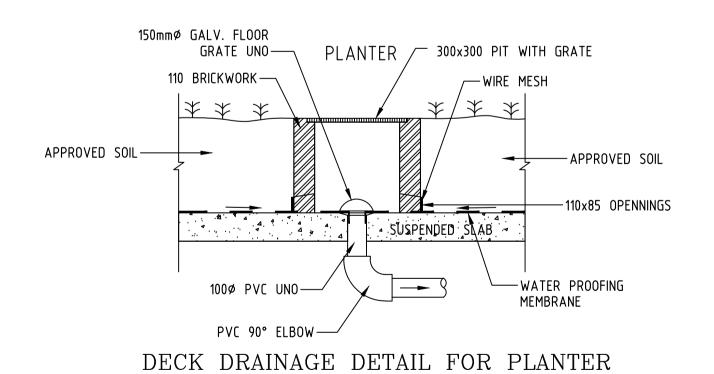

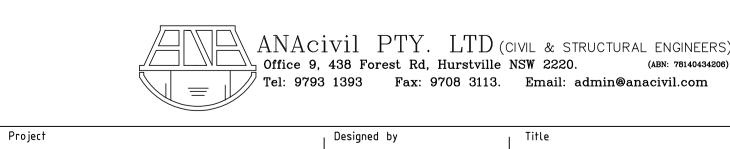

Project		Designed by			l Title		_I Scale		
PROPOSED DEVELOPMENT NO. 71-73 THOMAS STREET, PARRAMATTA.			N.SHAHID Drawn by N.SHAHID Checked by M. ZAIOOR Date 29/09/2021		H.	HYDRAULIC DETAILS		Rev.	
No.	Date	Revision		Ву	No.	Date	Revision		Ву
1	26/10/2021	MUSIC MODEL ADDED.		N.S	8	26/04/20:	3 AMENDED OSD		T.D
2	02/11/2021	AMENDED AS PER COUNCIL LETTER.		N.S					
3	31/10/2022	AMENDED AS PER COUNCIL LETTER.		T.D					
4	28/11/2022	AMENDED TO ARCHITECTURAL DWGS		T.D					
5	12/12/2022	AMENDED TO COUNCIL LETTER		T.D					
6	14/02/2022	AMENDED TO GEOTECHNICAL REPORT		T.D					
7	18/0/./2023	AMENDED TO COUNCIL LETTED		Τn					

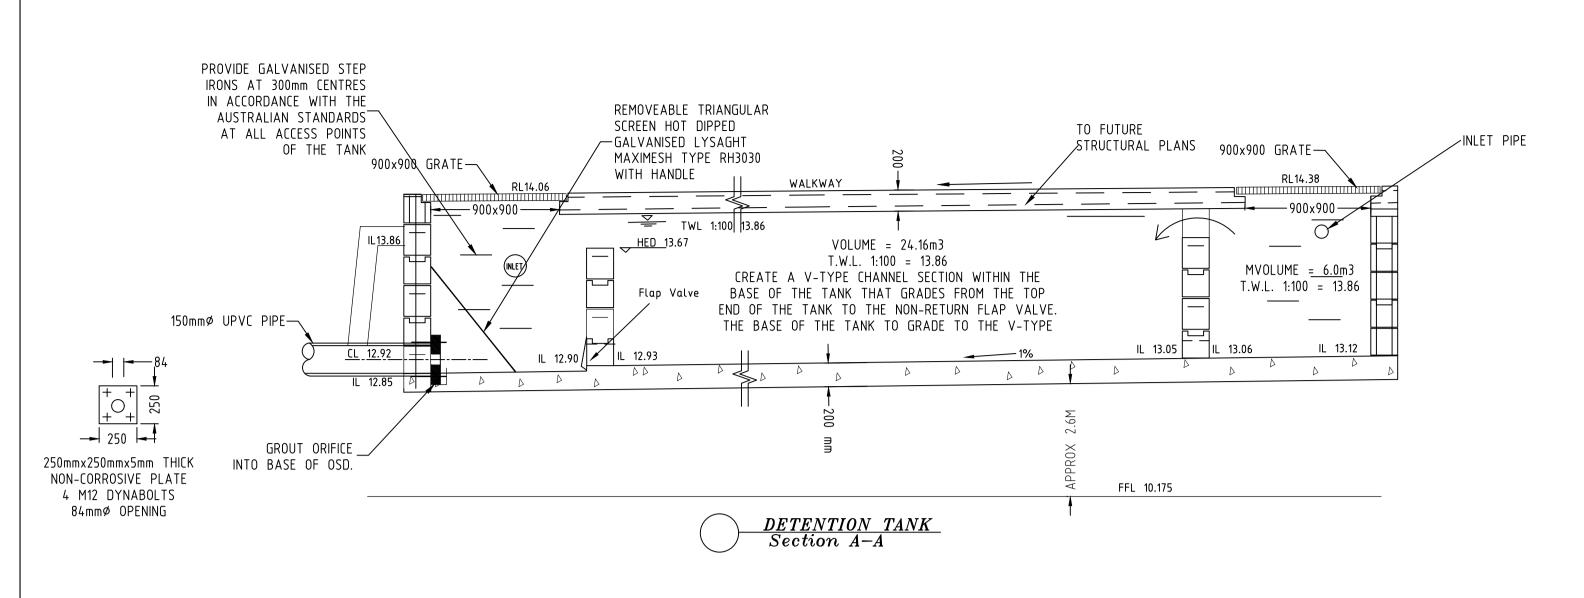


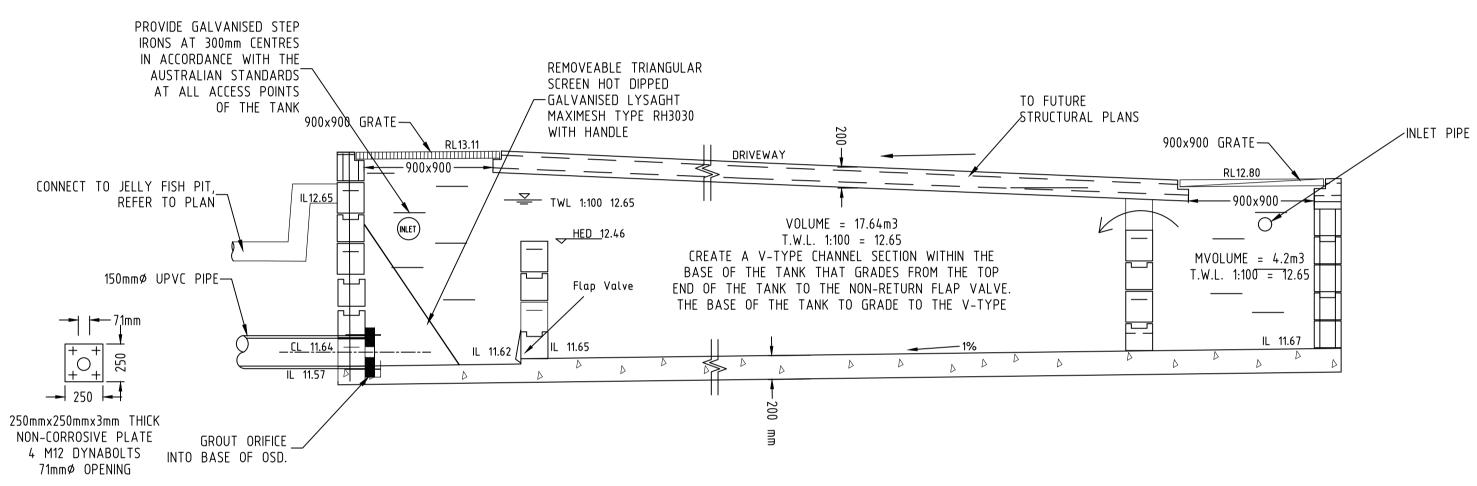


DETENTION TANK
Section B-B

OCEANGUARD PIT TYPE 2

DETAIL A

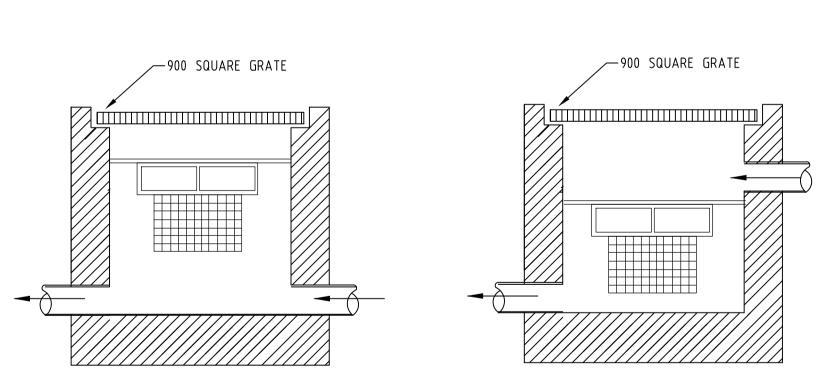

OCEANGUARD	PIT	TYPE	1
DETAIL	A		

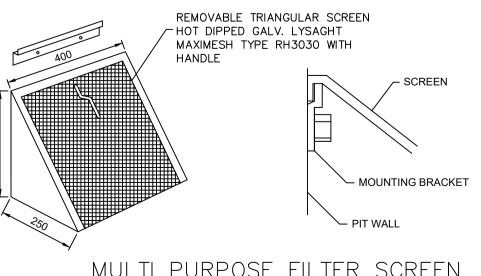

MULTI PURPOSE FILTER SCREEN

SCALE 1:10
PRODUCT CODE: MMMPS (MASCOT ENGINEERING)


MEDIUM DUTY HOT DIP GALV. STEEL GRATE
TUO IN
150 450x450 150
TYPICAL INTERNAL PIT

Address:	No. 71-3 Thomas St, Parramatta
Area (Ha) =	0.09110
OSD 1	
Storage Figure =	235.000
Volume Figure =	208.000
Basic Volume (m ³) =	21
Basic Discharge (m^3/sec) =	18.95
Area Drained to Storage (Ha) at least 75%	0.0802
Percentage Area Drained to Storage [D]/[A]	0.88
Storage per ha. of Contributing Area [B]/[D]	267.05
Enter Volume/PSD. Adjustment chart (Fig. 5.1)	174.91
using [F], and read new PSD in L/s/ha	1/4.91
Determine PSD $(L/s) = [G] \times [D]$	14.02
Maximum Head to Orifice Centre (m) =	0.8600
Select Orifice Diameter (m) =	0.084
Maximum Discharge (m ³) =	14.02
Head for High Early Discharge	0.7500
High Early Disharge [L] x ([M]/[K]) ^{0.5}	13.09
Approximate Mean Discharge	13.56
Average Discharge/ha = $[P]/[D]$	169.13
Enter Volume/PSD. Adjustment Chart (Fig. 5.1)	273.69
using [F], and read new PSD in L/s	2/3.09
Determine Final $SSR = [R]x\{D]$	21.94
NSI	1

OSD	1				

Address:	No. 71-3 Thomas St., Parramatta
OSD 2	
Area (Ha) =	0.07160
Storage Figure =	235.000
Volume Figure =	208.000
Basic Volume (m ³) =	17
Basic Discharge (m^3/sec) =	14.89
Area Drained to Storage (Ha) at least 75%	0.0630
Percentage Area Drained to Storage [D]/[A]	0.88
Storage per ha. of Contributing Area [B]/[D]	267.05
Enter Volume/PSD. Adjustment chart (Fig. 5.1) using [F], and read new PSD in L/s/ha	1/4 91
Determine PSD $(L/s) = [G] \times [D]$	
Maximum Head to Orifice Centre (m) =	
Select Orifice Diameter (m) =	0.071
Maximum Discharge (m^3) =	11.02
Head for High Early Discharge	
High Early Disharge [L] x ([M]/[K]) ^{0.5}	9.93
Approximate Mean Discharge	10.48
Average Discharge/ha = [P]/[D]	166.26
Enter Volume/PSD. Adjustment Chart (Fig. 5.1) using [F], and read new PSD in L/s	2// 14
Determine Final SSR = [R]x{D]	


OSD 2

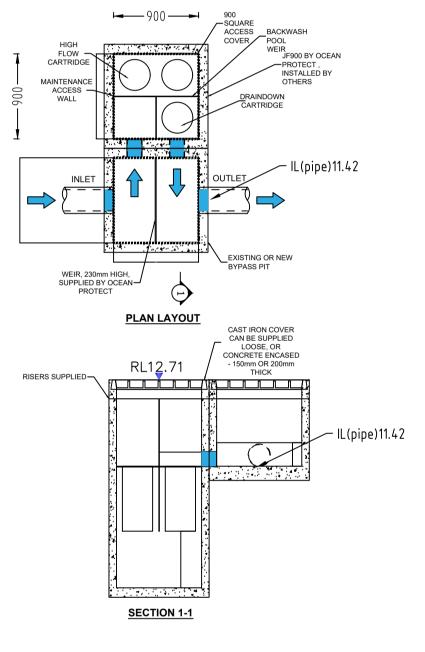


JELLY FISH PIT
DETAIL 1

	ANAcivil PTY. LTD (CIVIL & STRUCTURAL ENGINEERS) Office 9, 438 Forest Rd, Hurstville NSW 2220. (ABN: 78140434206) Tel: 9793 1393 Fax: 9708 3113. Email: admin@anacivil.com
Project	Designed by Title

Date 29/09/2021 2021409 H04 8 No. Date Revision By No. Date Revision B 1 26/10/2021 MUSIC MODEL ADDED. N.S. 8 26/04/2023 AMENDED OSD T. 2 02/11/2021 AMENDED AS PER COUNCIL LETTER. N.S. S. S. S. S. S. S.	Project			Designed by			l Title	Title Scale		
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/ 18/04/2023 AMENDED TO COUNCIL LETTER 1.D	7	18/04/2023	AMENDED TO COUNCIL LETTER		T.D					

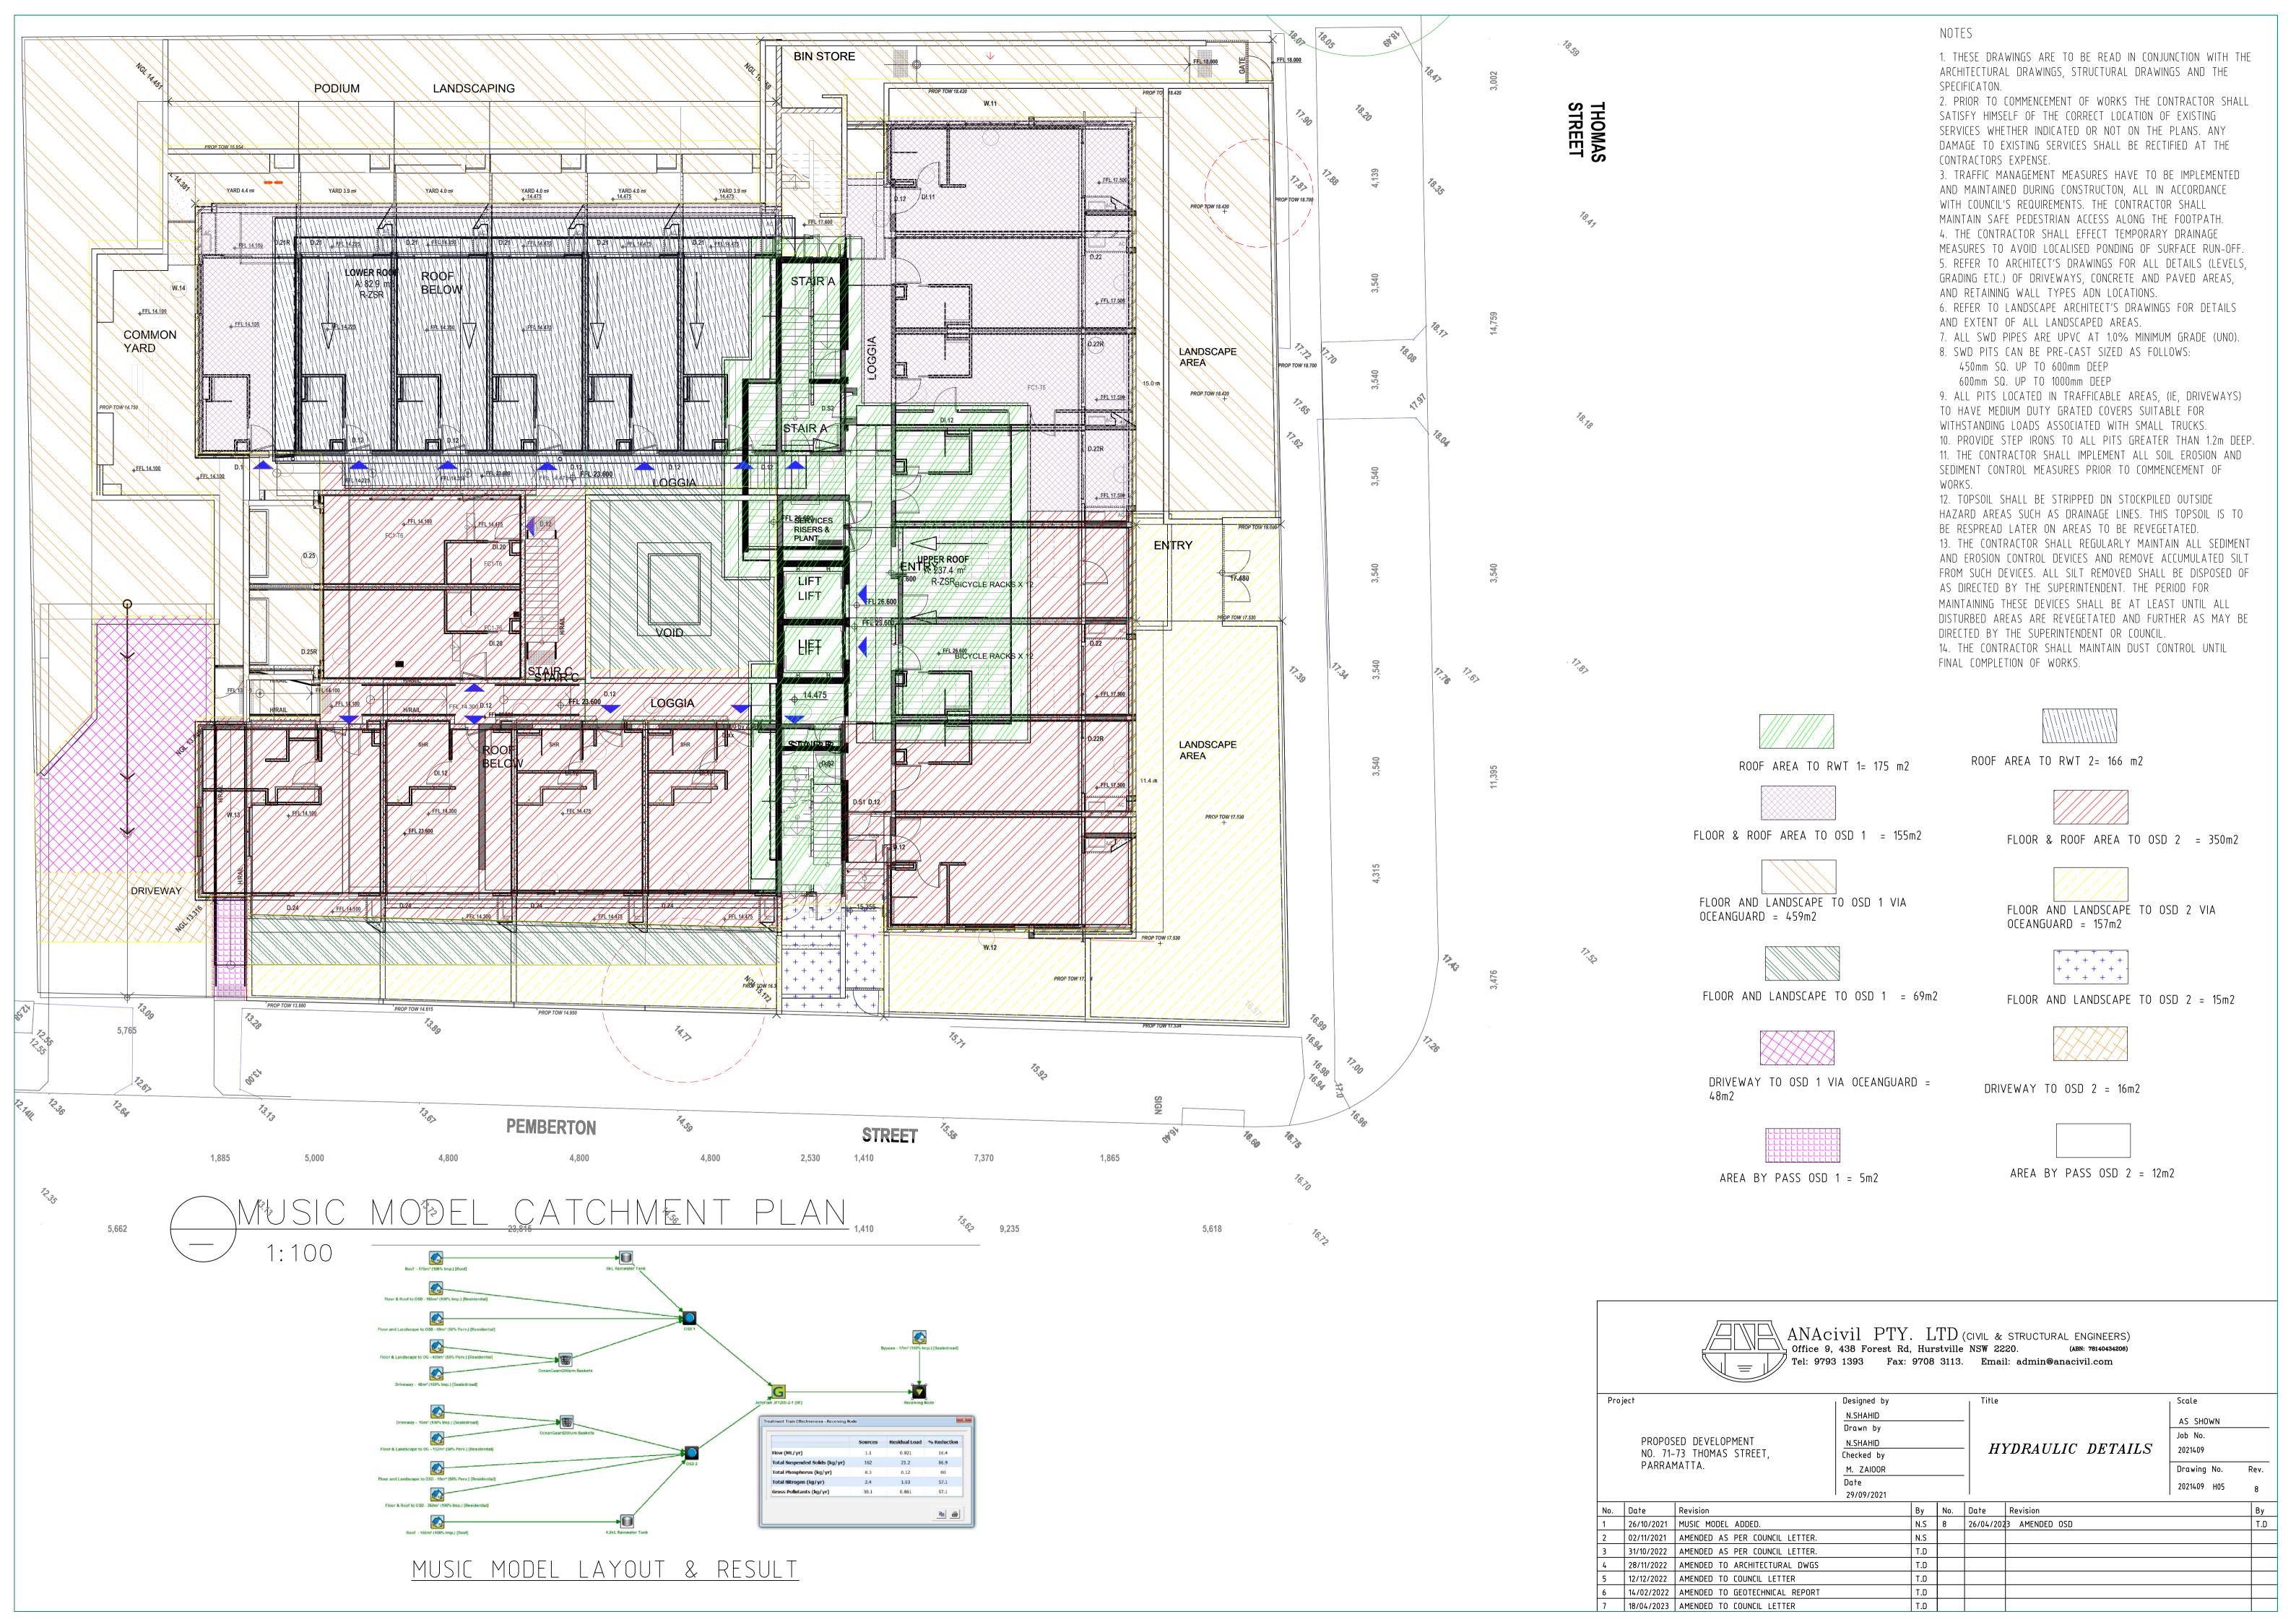

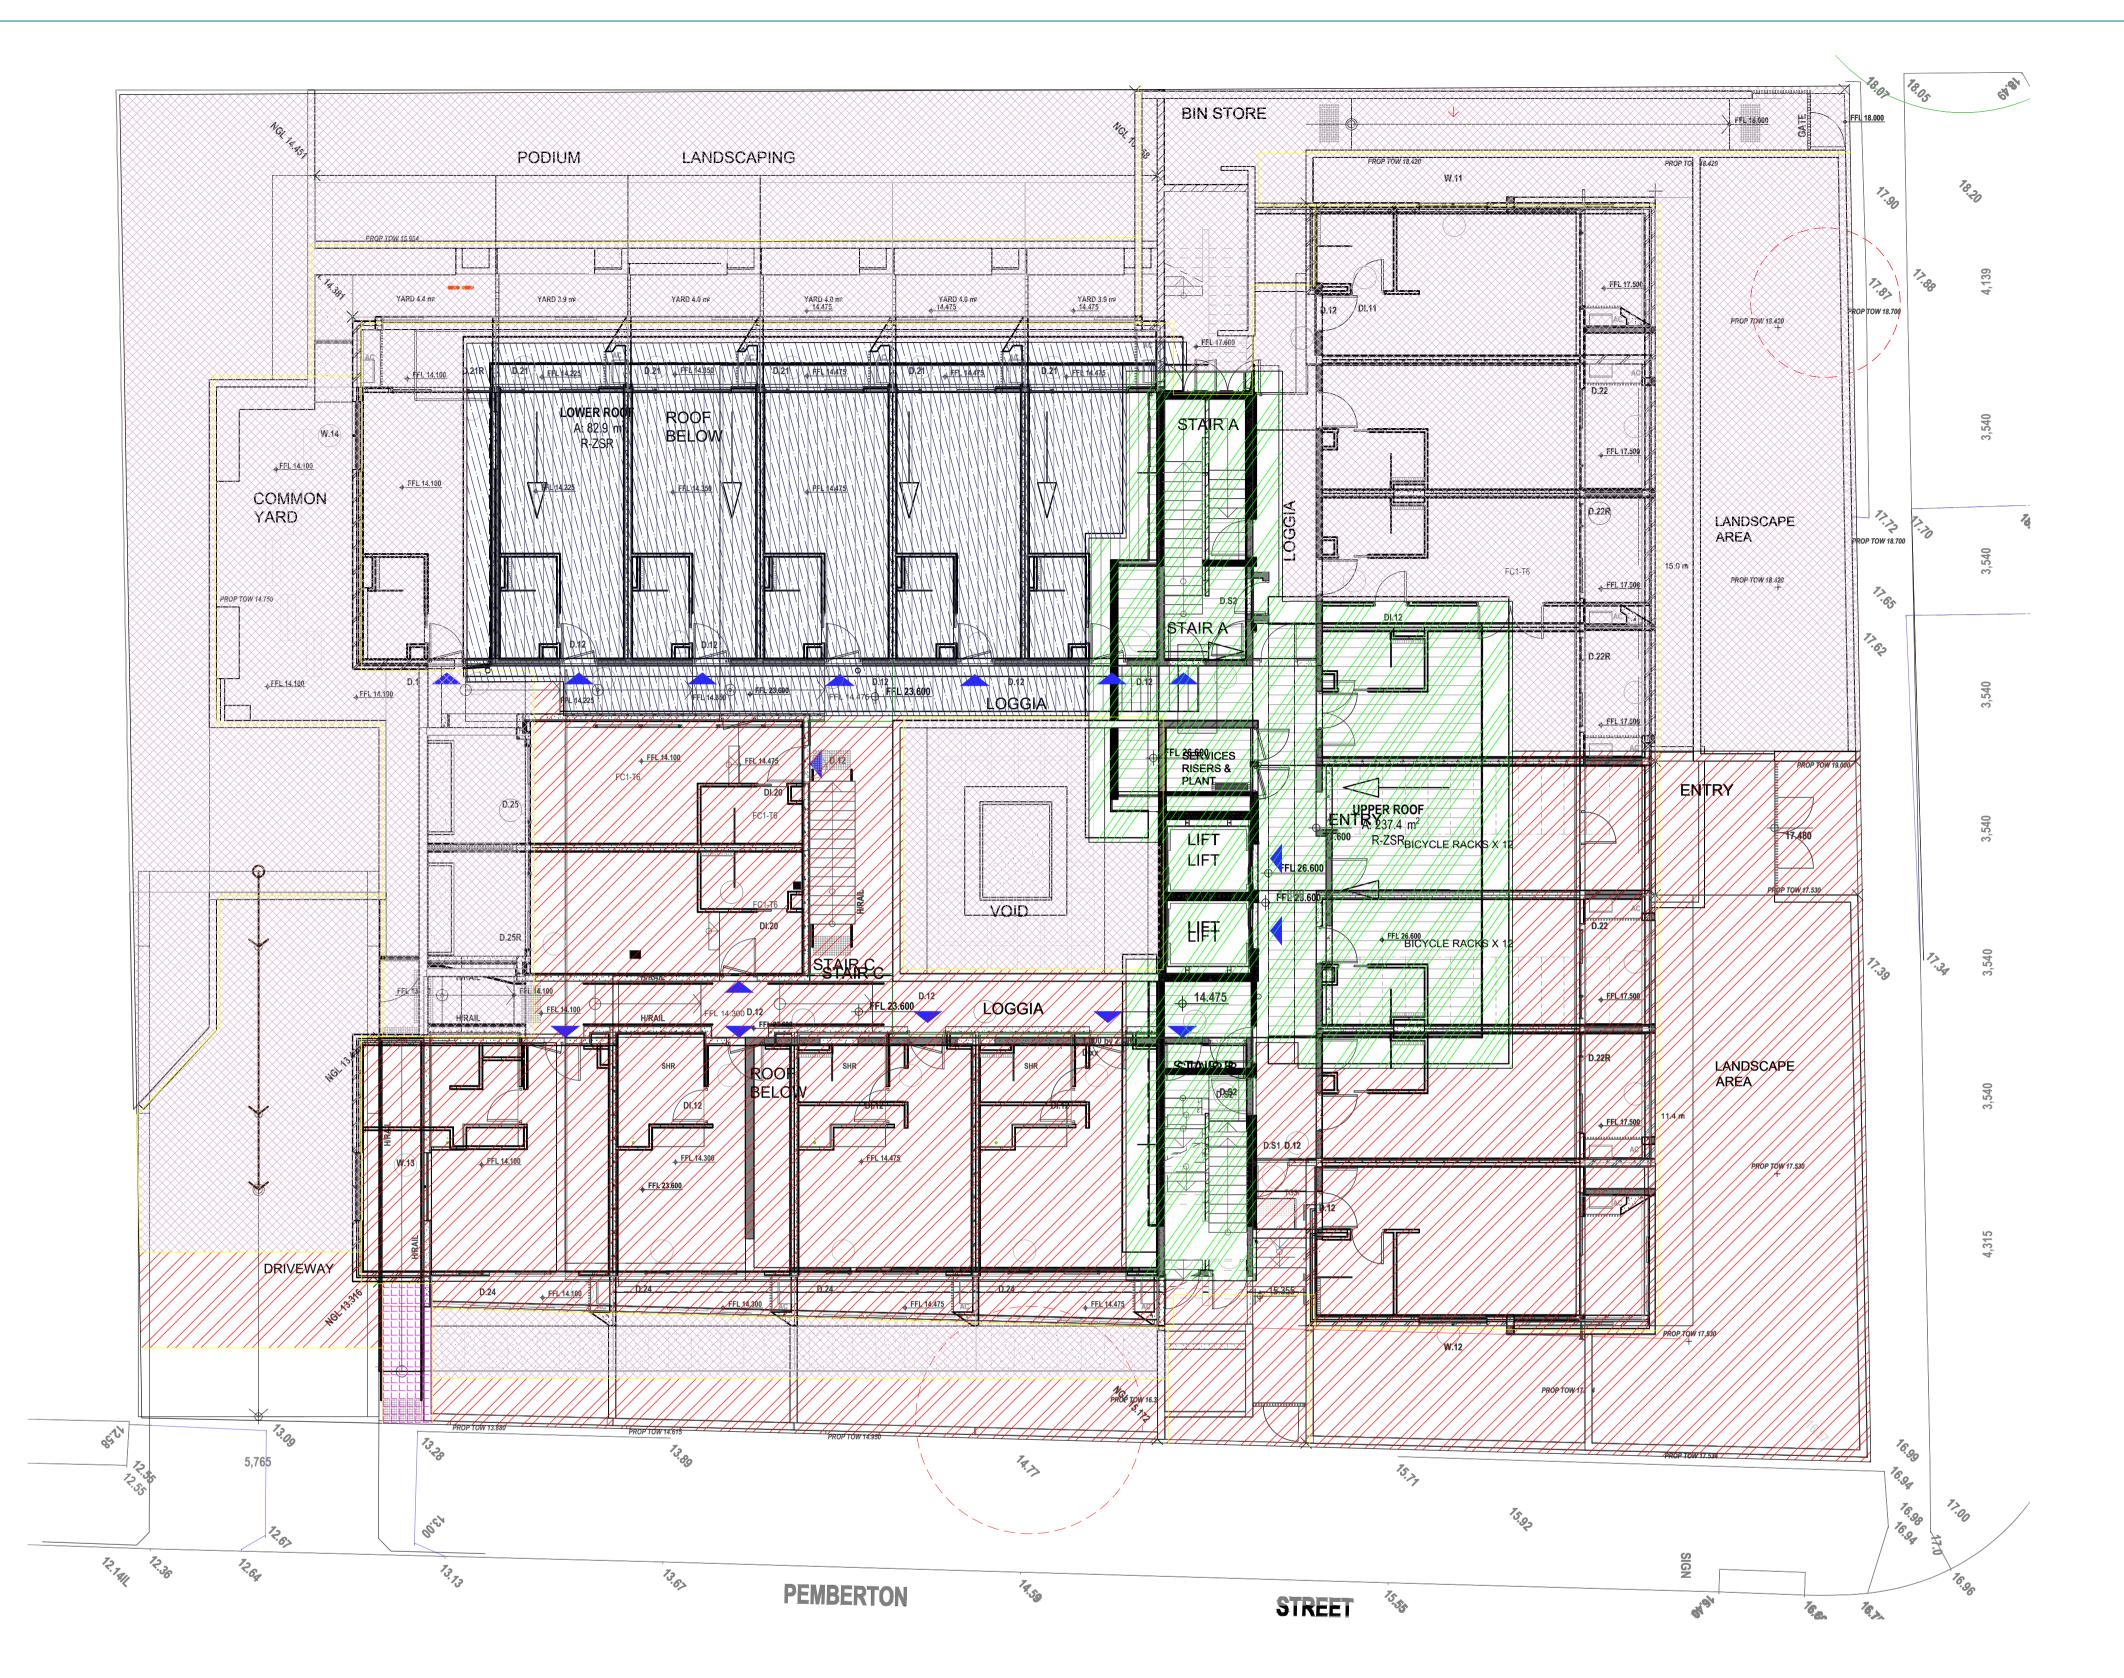

ROOF AREA TO RWT 1 = 175 m2



AREA TO DETENTION TANK 1 = 731m2



AREA BY PASS OSD 1 = 5m2



ROOF AREA TO RWT 2 = 166 m2



AREA TO DETENTION TANK 2 = 538m2



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18/04/2023 AMENDED TO COUNCIL LETTER

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